NOTE RE. SERVICES

APPROXIMATE LOCATIONS OF EXISTING SERVICES SHOWN ON LONGITUDINAL SECTION. EXACT LOCATIONS & DEPTHS TO BE ACCURATELY LOCATED BY THE BUILDING CONTRACTOR BY CONTACTING THE RELEVANT AUTHORITIES BEFORE COMMENCEMENT OF ANY WORKS



NOTES

1. ALL LINES ARE TO BE MIN. 100 Φ UPVC @ MIN 1.0% GRADE UNLESS NOTED OTHERWISE.

2. IT IS THE CONTRACTORS RESPONSIBILITY TO LOCATE & LEVEL ALL EXISTING SERVICES PRIOR TO THE COMMENCEMENT OF ANY EARTHWORKS. ALL DESIGN LEVELS SHOWN ON PLAN SHALL BE VERIFIED ON SITE PRIOR TO THE COMMENCEMENT OF ANY WORK.

3. ALL PIPES TO HAVE MIN 200mm COVER IF LOCATED WITHIN PROPERTY.

4. ALL PITS IN DRIVEWAYS BE HEAVY DUTY GRATES. DIRECT SURFACE FLOW TO ALL GRATED SURFACE INLET PITS.

5. ALL WORK DO BE DONE IN ACCORDANCE WITH AS/NZ 3500. 3. 2: 2003 AND COUNCIL SPECIFICATIONS.

6. LOCATION OF DOWNPIPES & FLOOR WASTES ARE INDICATIVE ONLY. DOWNPIPE & FLOOR WASTE SIZE, LOCATION & QUANTITY TO BE DETERMINED BY BUILDER & IN ACCORDANCE WITH RELEVANT AUSTRALIAN STANDARDS.

7. THIS PLAN IS TO BE READ IN CONJUNCTION WITH THE ARCHITECTURAL, LANDSCAPE AND STRUCTURAL PLANS.

8. ANY DISCREPANCIES OR OMISSIONS SHALL BE REFERRED TO THE DESIGN ENGINEER FOR RESOLUTION.

9. ALL PITS OR GRATES IN TRAFFICABLE AREAS TO BE HEAVY DUTY.

10. ALL GUTTERS WILL BE FITTED WITH LEAF GUARDS AND SHOULD BE INSPECTED AND CLEANED TO ENSURE LEAF LITTER CANNOT ENTER THE DOWNPIPES

SYMBOLS

EDP

FINISHED FLOOR LEVEL T. K. TOP OF KERB PIT SURFACE LEVEL INVERT LEVEL STORMWATER DRAINAGE PIPE DOWNPIPE TO RAINWATER TANK 100 ф DOWN PIPE (U.N.O.) SPREADER INSPECTION EYE $\bigotimes FW$ FLOOR WASTE 150 Φ GRATED INLET PIT

> GRATED DRAIN OVERLAND FLOW PATH

VERTICAL DROP EXISTING 100 φ DOWN PIPE (U. N. O.)

EMERGENCY SPILTTER

EXISTING STORMWATER DRAINAGE PIPE

PUMP WELL 2.00x1.50x1.00 DEPTH OF WATER TWL 45.60 RL 45.90 IL 44.60

(SUBMERSIBLE AUTOMATIC PUMPS WORKING AT ALTERNATIVE LEVELS WITH ALARM)

Parking Place x 23 1:40 Ø100@1% MIN. **Ø**150@1% MIN. **⊅**100@1% MIN. ♥65 PRESSURE PIPE TO OSD √450x450 PIT RL 45.90 IL 45.45 200 GRATE DRAIN RL 43L645850 IL 45. 40 \$\phi_100 \text{SUBSOIL PIPE}\$

- CONVEX MIRROR

CONVEX MIRROR

71.749

91.408

BASEMENT STORMWATER DRAINAGE PLAN

Project

SCALE 1:100

To Ground

SH IN 02/08/21 FOR DA APPROVAL FOR DA APPROVAL SH IN 15/07/21 FOR DA APPROVAL SH IN 22/07/19 By App Date By App Date Rev Description

STRONGHOLD ENGINEERS SHENS Email: admin@shens.com.au Suite 79 89-97 JONES STREET **ULTIMO NSW 2007**

Engineering Consultant



619-621 HUME HWY, CASULA, NSW


BASEMENT STORMWATER DRAINAGE PLAN

Drawing Title

THESE DRAWINGS AND THE DESIGNS WITHIN ARE COPYRIGHT. THEY ARE NOT TO BE USED FOR ANY PURPOSE OTHER THAN THE NOMINATED PROJECT. THE DRAWINGS REMAIN THE PROPERTY OF SHENS AND ARE NOT TO BE REPRODUCED OR ALTERED WITHOUT WRITTEN PERMISSION.

E.	
TY OR	

THESE DRAWINGS AND THE DESIGNS WITHIN ARE COPYRIGHT. THEY ARE NOT TO BE USED FOR	Project Number SH18171	Drawing Number ST01	Revison	1 0 4 0
ANY PURPOSE OTHER THAN THE NOMINATED PROJECT. THE DRAWINGS REMAIN THE PROPERTY OF SHENS AND ARE NOT TO BE REPRODUCED OR ALTERED WITHOUT WRITTEN PERMISSION.	Engineer SH	Drawn	<u> </u>	20 30
NOT FOR CONSTRUCTION	JUL 2019	Scale 1:100	A1	

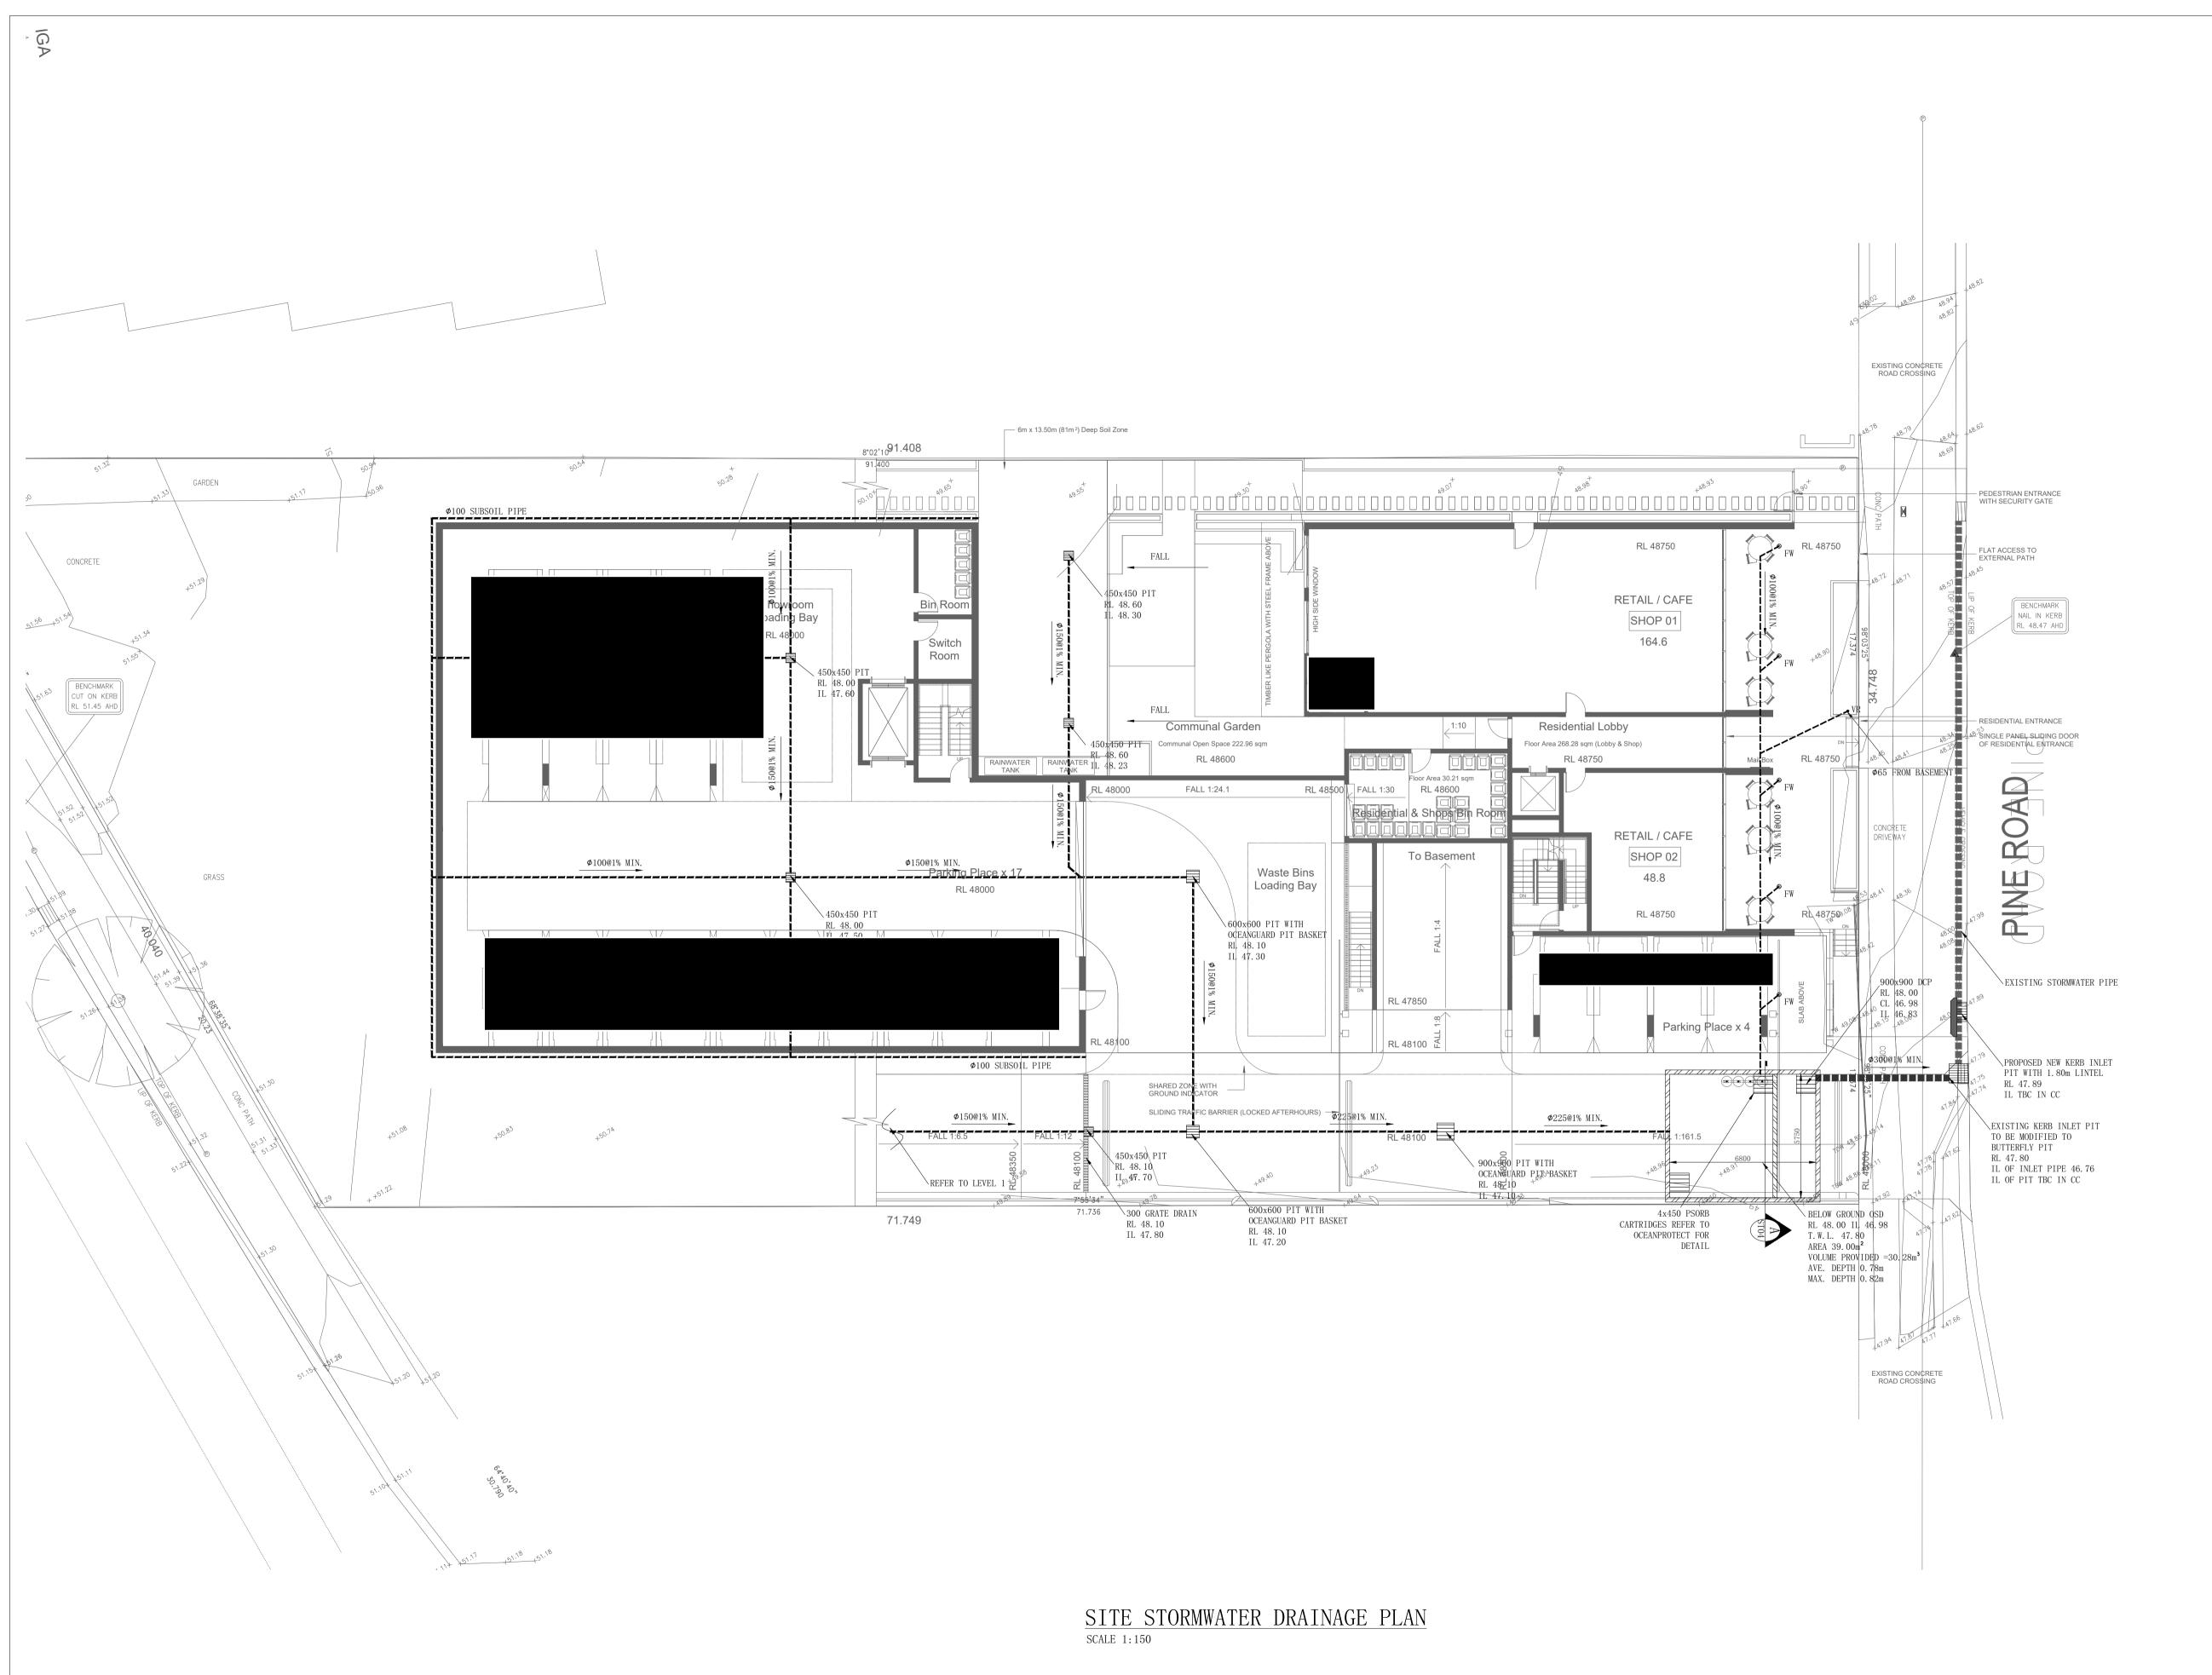

NOTE RE. SERVICES

APPROXIMATE LOCATIONS OF EXISTING SERVICES SHOWN ON LONGITUDINAL SECTION. EXACT LOCATIONS & DEPTHS TO BE ACCURATELY LOCATED BY THE BUILDING CONTRACTOR BY CONTACTING THE RELEVANT AUTHORITIES BEFORE COMMENCEMENT OF ANY WORKS



NOTES


- 1. ALL LINES ARE TO BE MIN. 100 Φ UPVC @ MIN 1.0% GRADE UNLESS NOTED OTHERWISE.
- 2. IT IS THE CONTRACTORS RESPONSIBILITY TO LOCATE & LEVEL ALL EXISTING SERVICES PRIOR TO THE COMMENCEMENT OF ANY EARTHWORKS. ALL DESIGN LEVELS SHOWN ON PLAN SHALL BE VERIFIED ON SITE PRIOR TO THE COMMENCEMENT OF ANY WORK.
- 3. ALL PIPES TO HAVE MIN 200mm COVER IF LOCATED WITHIN PROPERTY.
- 4. ALL PITS IN DRIVEWAYS BE HEAVY DUTY GRATES. DIRECT SURFACE FLOW TO ALL GRATED SURFACE INLET PITS.
- 5. ALL WORK DO BE DONE IN ACCORDANCE WITH AS/NZ 3500. 3. 2:2003 AND COUNCIL SPECIFICATIONS.
- 6. LOCATION OF DOWNPIPES & FLOOR WASTES ARE INDICATIVE ONLY. DOWNPIPE & FLOOR WASTE SIZE, LOCATION & QUANTITY TO BE DETERMINED BY BUILDER & IN ACCORDANCE WITH RELEVANT AUSTRALIAN STANDARDS.
- 7. THIS PLAN IS TO BE READ IN CONJUNCTION WITH THE ARCHITECTURAL, LANDSCAPE AND STRUCTURAL PLANS.
- 8. ANY DISCREPANCIES OR OMISSIONS SHALL BE REFERRED TO THE DESIGN ENGINEER FOR RESOLUTION.
- 9. ALL PITS OR GRATES IN TRAFFICABLE AREAS TO BE HEAVY DUTY.
- 10. ALL GUTTERS WILL BE FITTED WITH LEAF GUARDS AND SHOULD BE INSPECTED AND CLEANED TO ENSURE LEAF LITTER CANNOT ENTER THE DOWNPIPES

SYMBOLS

FINISHED FLOOR LEVEL T. K. TOP OF KERB PIT SURFACE LEVEL INVERT LEVEL STORMWATER DRAINAGE PIPE DOWNPIPE TO RAINWATER TANK 100ф DOWN PIPE (U.N.O.) SPREADER INSPECTION EYE ⊗FW FLOOR WASTE 150 φ GRATED INLET PIT GRATED DRAIN

> OVERLAND FLOW PATH ES---EMERGENCY SPILTTER VERTICAL DROP

EDP EXISTING 100 φ DOWN PIPE (U.N.O.) EXISTING STORMWATER DRAINAGE PIPE

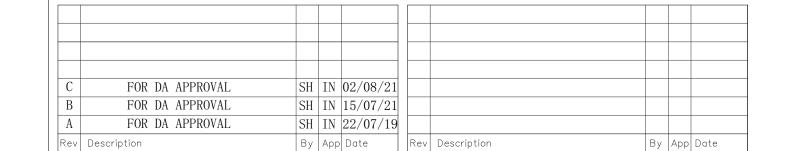








Project



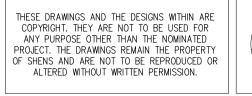

HESE DRAWINGS AND THE DESIGNS WITHIN ARE COPYRIGHT. THEY ARE NOT TO BE USED FOR		Project Number SH18171	Drawing Number	Revison C
ANY PURPOSE OTHER THAN THE NOMINATED ROJECT. THE DRAWINGS REMAIN THE PROPERTY F SHENS AND ARE NOT TO BE REPRODUCED OR ALTERED WITHOUT WRITTEN PERMISSION.		Engineer SH	Drawn IN	1
NOT FOR CONSTRUCTION	JUL 2019	Scale 1:100	A1	

NOTE RE. SERVICES APPROXIMATE LOCATIONS OF EXISTING SERVICES SHOWN ON LONGITUDINAL SECTION. EXACT LOCATIONS & DEPTHS TO BE ACCURATELY LOCATED BY THE BUILDING CONTRACTOR BY CONTACTING THE RELEVANT AUTHORITIES BEFORE COMMENCEMENT OF ANY WORKS EFORE YOU DI

1. ALL LINES ARE TO BE MIN. 100 Φ UPVC @ MIN 1.0% GRADE

2. IT IS THE CONTRACTORS RESPONSIBILITY TO LOCATE & LEVEL ALL EXISTING SERVICES PRIOR TO THE COMMENCEMENT OF ANY EARTHWORKS. ALL DESIGN LEVELS SHOWN ON PLAN SHALL BE VERIFIED ON SITE PRIOR TO THE COMMENCEMENT OF ANY WORK.

3. ALL PIPES TO HAVE MIN 200mm COVER IF LOCATED WITHIN

4. ALL PITS IN DRIVEWAYS BE HEAVY DUTY GRATES. DIRECT SURFACE FLOW TO ALL GRATED SURFACE INLET PITS.

6. LOCATION OF DOWNPIPES & FLOOR WASTES ARE INDICATIVE

7. THIS PLAN IS TO BE READ IN CONJUNCTION WITH THE

ARCHITECTURAL, LANDSCAPE AND STRUCTURAL PLANS.

9. ALL PITS OR GRATES IN TRAFFICABLE AREAS TO BE HEAVY

10. ALL GUTTERS WILL BE FITTED WITH LEAF GUARDS AND SHOULD BE INSPECTED AND CLEANED TO ENSURE LEAF LITTER CANNOT

TOP OF KERB

SPREADER

INSPECTION EYE

FLOOR WASTE 150 Φ

GRATED INLET PIT

OVERLAND FLOW PATH

EMERGENCY SPILTTER

EXISTING 100 φ DOWN PIPE (U. N. O.) EXISTING STORMWATER DRAINAGE PIPE

VERTICAL DROP

GRATED DRAIN

FINISHED FLOOR LEVEL

PIT SURFACE LEVEL INVERT LEVEL

STORMWATER DRAINAGE PIPE DOWNPIPE TO RAINWATER TANK 100 ф DOWN PIPE (U.N.O.)

8. ANY DISCREPANCIES OR OMISSIONS SHALL BE REFERRED TO THE

TO BE DETERMINED BY BUILDER & IN ACCORDANCE WITH

ONLY. DOWNPIPE & FLOOR WASTE SIZE, LOCATION & QUANTITY

5. ALL WORK DO BE DONE IN ACCORDANCE WITH AS/NZ 3500. 3. 2:2003 AND COUNCIL SPECIFICATIONS.

RELEVANT AUSTRALIAN STANDARDS.

DESIGN ENGINEER FOR RESOLUTION.

ENTER THE DOWNPIPES

T. K.

⊗ FW


SYMBOLS

NOTES

PROPERTY.

DUTY.

UNLESS NOTED OTHERWISE.

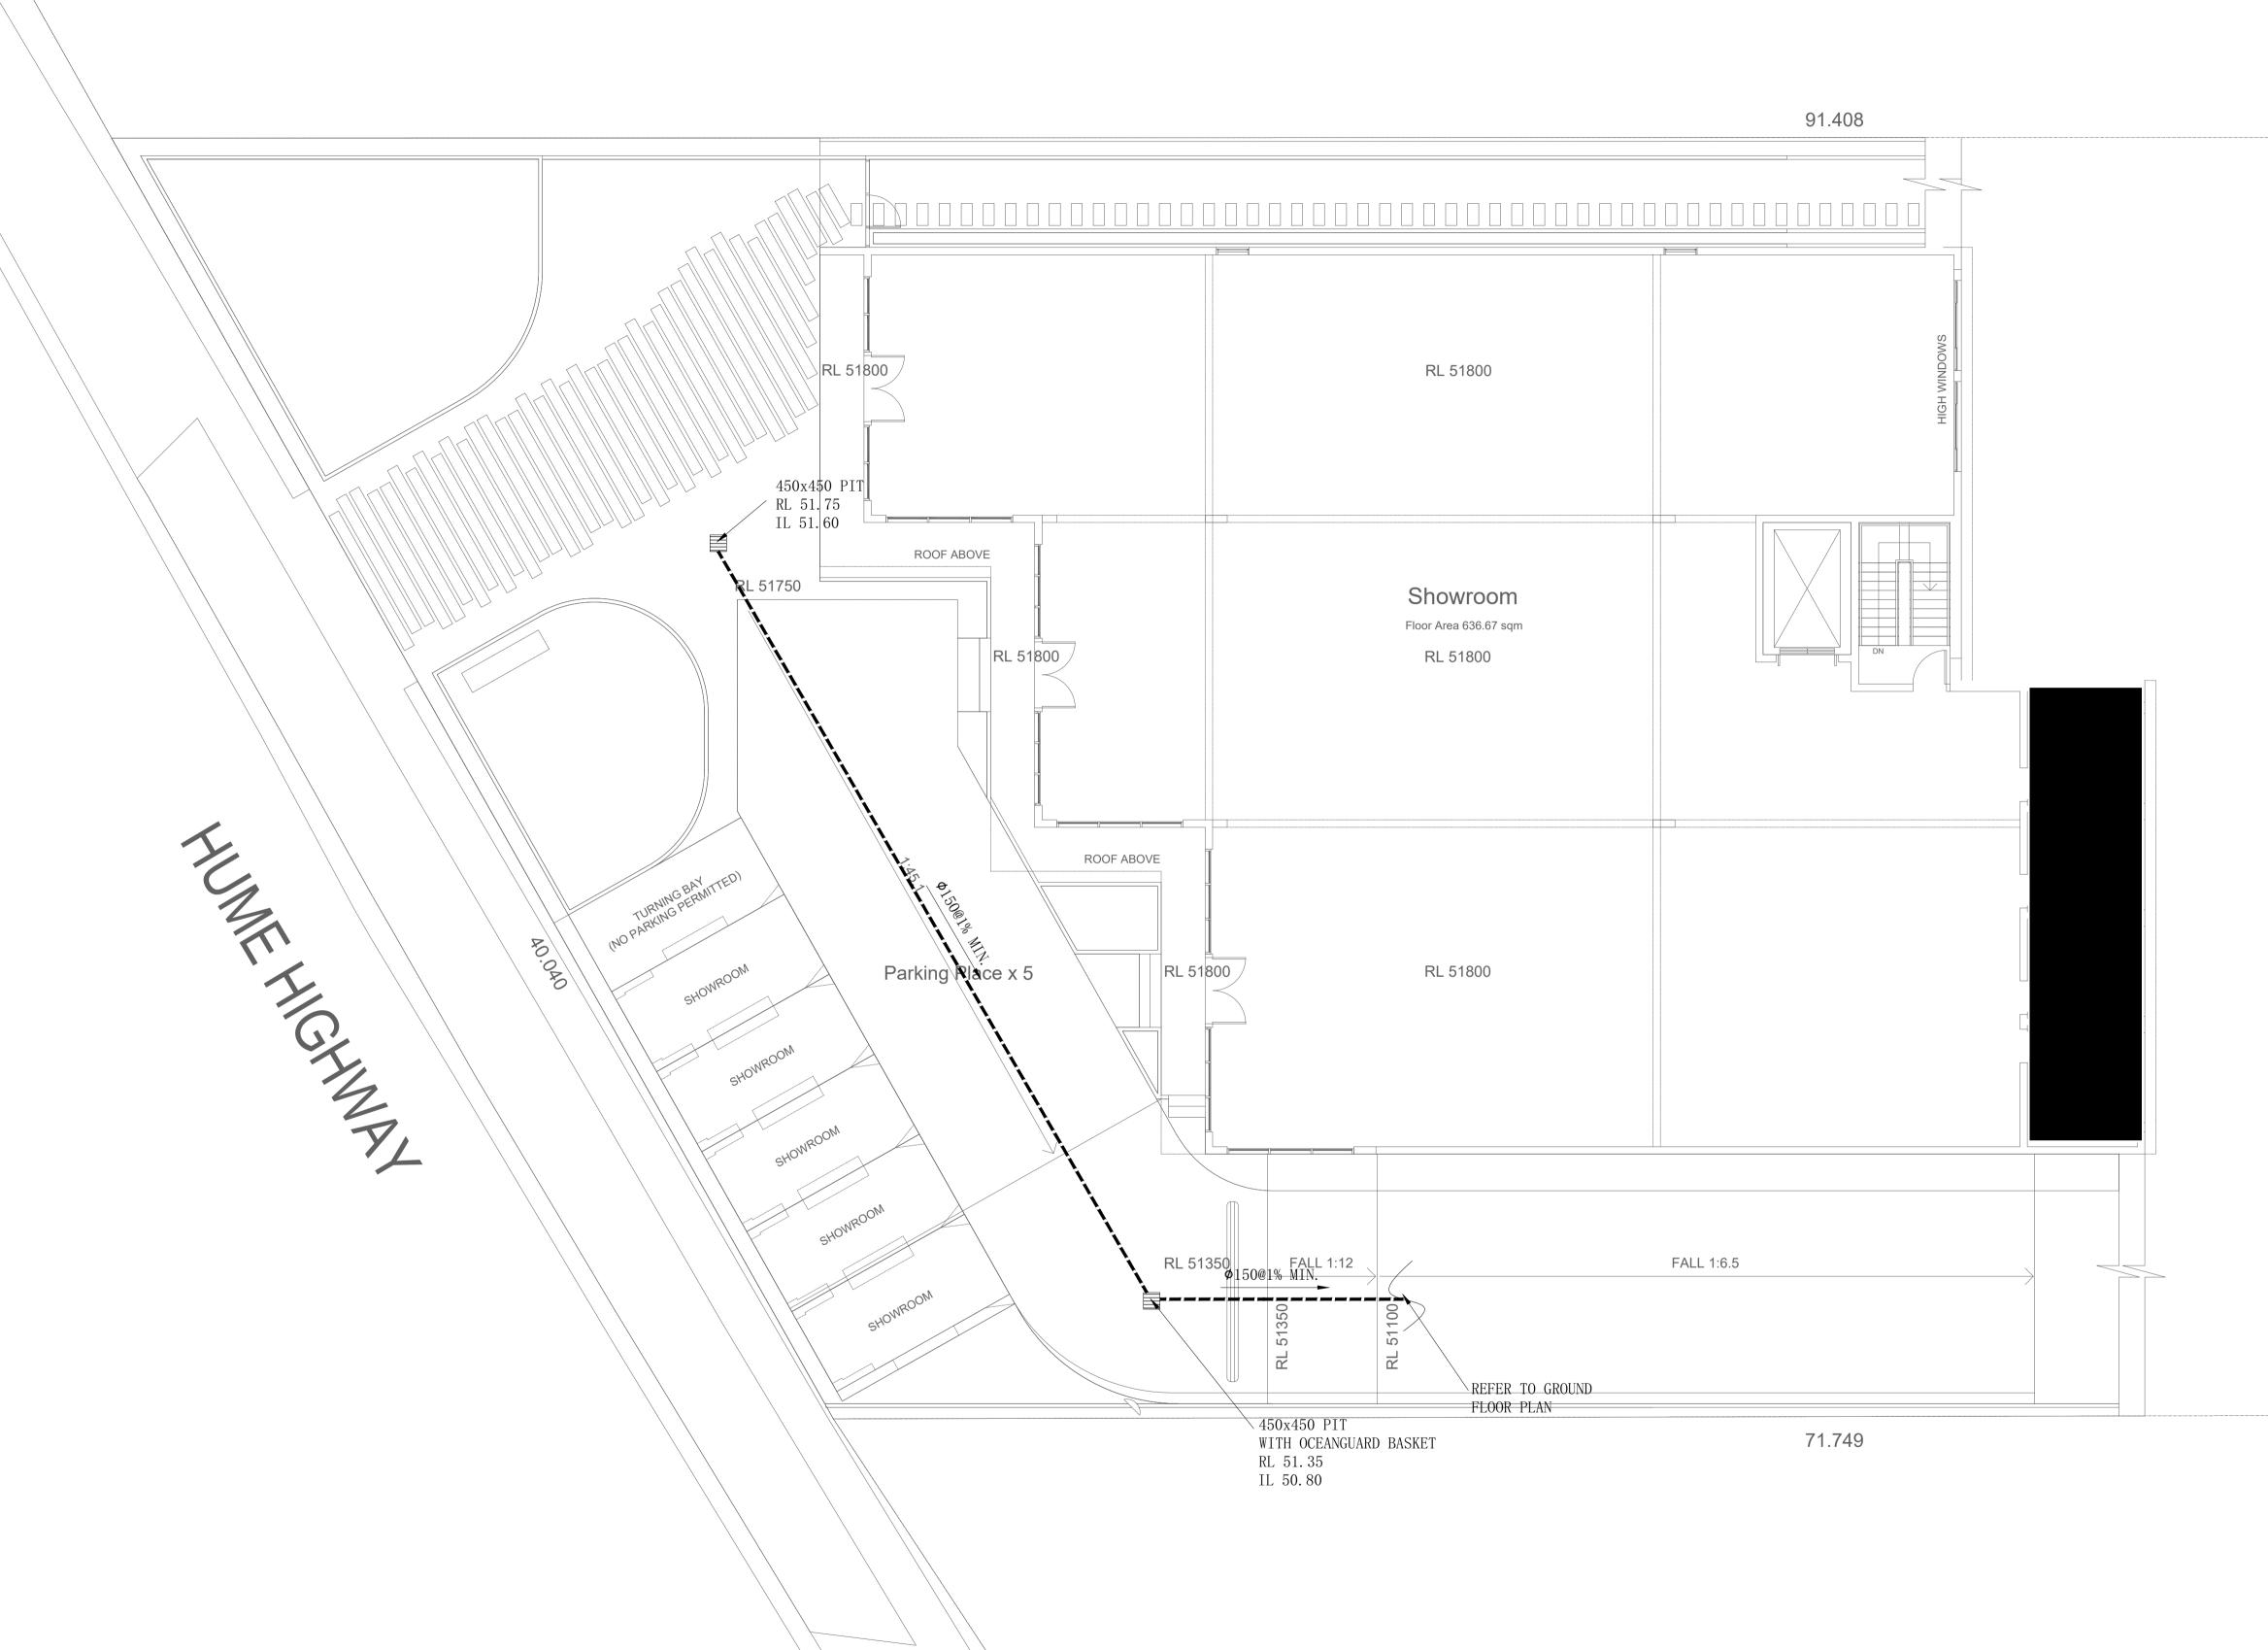

LEVEL 1 STORMWATER DRAINAGE PLAN SCALE 1:100

С	FOR DA APPROVAL	SH	IN	02/08/21					
В	FOR DA APPROVAL	SH	IN	15/07/21					
A	FOR DA APPROVAL	SH	IN	22/07/19					
Rev	Description	Ву	Арр	Date	Rev	Description	Ву	Арр	Date



Engineering Consultant



619-621 HUME HWY, CASULA, NSW


LEVEL 1 STORMWATER DRAINAGE PLAN

Drawing Title

THESE DRAWINGS AND THE DESIGNS WITHIN ARE COPYRIGHT. THEY ARE NOT TO BE USED FOR ANY PURPOSE OTHER THAN THE NOMINATED PROJECT. THE DRAWINGS REMAIN THE PROPERTY OF SHENS AND ARE NOT TO BE REPRODUCED OR ALTERED WITHOUT WRITTEN PERMISSION.
--

THESE DRAWINGS AND THE DESIGNS WITHIN ARE COPYRIGHT. THEY ARE NOT TO BE USED FOR ANY PURPOSE OTHER THAN THE NOMINATED PROJECT. THE DRAWINGS REMAIN THE PROPERTY OF SHENS AND ARE NOT TO BE REPRODUCED OR	Project Number SH18171 Engineer	Drawing Number ST03	Revison C
ALTERED WITHOUT WRITTEN PERMISSION.	SH	IN	
NOT FOR CONSTRUCTION	JUL 2019	Scale 1:100	A1

— HIGH LEVEL LIGHT ROTARY CONTROL SWITCHES — TERMINAL BLOCK 900x900 GRATE-65mm PUMP LINE ✓ GATE VALVE PUMP 2 START LEVEL REGULATOR INSTALL WATERSTOP - KAMLOK QUICK RELEASE COUPLING CHECK VALVE (SWING) — PUMP 1 START LEVEL REGULATOR DUAL SUBMERSIBLE PUMPS SP1 OPERATING ALTERNATIVELY - REINFORCED HIGH PRESSURE HOSES AND PUMPING AT KS30 PUMPS TO BE INSTALLED TO MANUFACTURERS DETAIL BASEMENT PUMP WELL SECTION

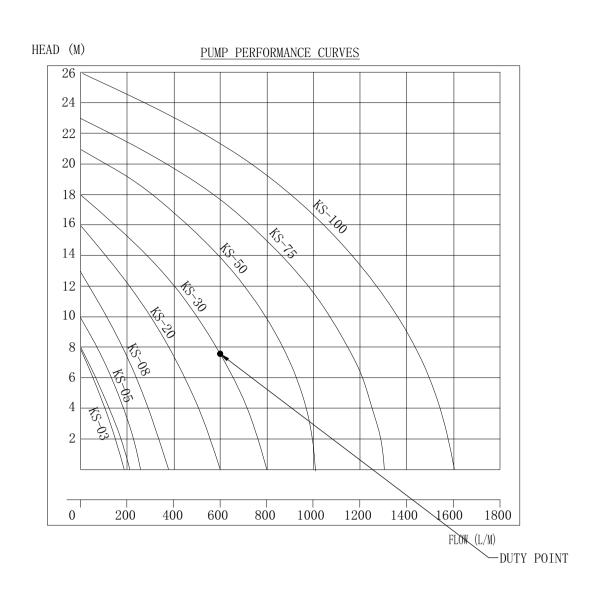

WARNING

PUMP OUT SYSTEM FAILURE IN BASEMENT WHEN LIGHT IS FLASHING AND SIREN SOUNDING

HEIGHT 150mm

WIDTH 200mm

BASEMENT PUMP OUT FAILURE

WARNING SIGN


NOTE:-


1- SIGN SHALL BE PLACED IN A CLEAR AND VISIBLE LOCATION

WHERE VEHICLES ENTER THE BASEMENT. COLOURS :; -


> WARNING - RED BORDER AND OTHER COLOURING - BLACK

NOTE: A SUITABLE ALARM SYSTEM POSITIONED AT ENTRANCE OF BASEMENT CARPARK TO PROVIDE A FLOOD WARNING IN CASE OF PUMP FAILURE (TO COUNCILS SPEC). AS SHOWN ABOVE.

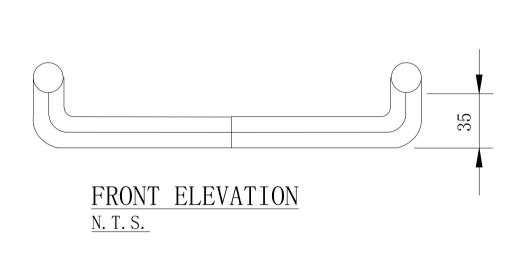

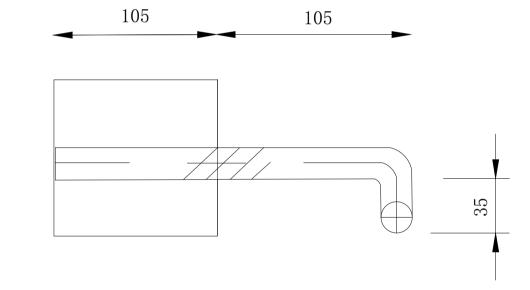

SIDE ELEVATION

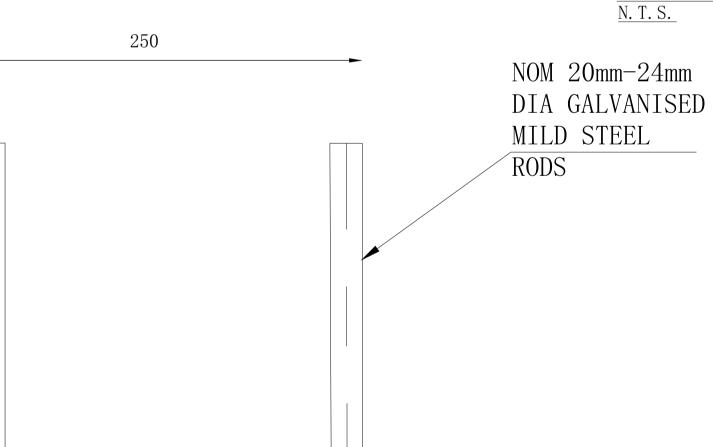

Project

<u>PLAN</u> N. T. S.

STEP IRON DETAILS <u>N. T. S.</u>

NOTE: INSTALL WHERE PITS ARE DEEPER THAN 1000mm

FOR DA APPROVAL SH IN 02/08/21 FOR DA APPROVAL SH IN 15/07/21 FOR DA APPROVAL SH IN 22/07/19 By App Date By App Date Rev Description

φ 100 PIPE

TYPICAL SECTION THROUGH SUBSOIL HARD PIPE N. T. S.


WATERPROOF MEMBRANE OVER 30 SAND BLIND AND 75mm BLUE METAL (10mm AGGREGATE)








Drawing Title BASEMENT STORMWATER DRAINAGE DETAIL

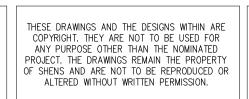

NOT FOR CONSTRUCT

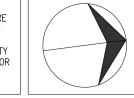

	Project Number	Drawing Number	Revison
	SH18171	ST04	С
	Engineer SH	Drawn	
ION	JUL 2019	Scale 1:100	A1

NOTE RE. SERVICES APPROXIMATE LOCATIONS OF EXISTING SERVICES SHOWN ON LONGITUDINAL SECTION. EXACT LOCATIONS & DEPTHS TO BE ACCURATELY LOCATED BY THE BUILDING CONTRACTOR BY CONTACTING THE RELEVANT AUTHORITIES BEFORE COMMENCEMENT OF ANY WORKS



NOTES

- 1. ALL LINES ARE TO BE MIN. 100 Φ UPVC @ MIN 1.0% GRADE UNLESS NOTED OTHERWISE.
- 2. IT IS THE CONTRACTORS RESPONSIBILITY TO LOCATE & LEVEL ALL EXISTING SERVICES PRIOR TO THE COMMENCEMENT OF ANY EARTHWORKS. ALL DESIGN LEVELS SHOWN ON PLAN SHALL BE VERIFIED ON SITE PRIOR TO THE COMMENCEMENT OF ANY WORK.
- 3. ALL PIPES TO HAVE MIN 200mm COVER IF LOCATED WITHIN PROPERTY.
- 4. ALL PITS IN DRIVEWAYS BE HEAVY DUTY GRATES. DIRECT SURFACE FLOW TO ALL GRATED SURFACE INLET PITS.
- 5. ALL WORK DO BE DONE IN ACCORDANCE WITH AS/NZ 3500. 3. 2: 2003 AND COUNCIL SPECIFICATIONS.
- 6. LOCATION OF DOWNPIPES & FLOOR WASTES ARE INDICATIVE ONLY. DOWNPIPE & FLOOR WASTE SIZE, LOCATION & QUANTITY TO BE DETERMINED BY BUILDER & IN ACCORDANCE WITH RELEVANT AUSTRALIAN STANDARDS.
- 7. THIS PLAN IS TO BE READ IN CONJUNCTION WITH THE ARCHITECTURAL, LANDSCAPE AND STRUCTURAL PLANS.
- 8. ANY DISCREPANCIES OR OMISSIONS SHALL BE REFERRED TO THE DESIGN ENGINEER FOR RESOLUTION.
- 9. ALL PITS OR GRATES IN TRAFFICABLE AREAS TO BE HEAVY
- 10. ALL GUTTERS WILL BE FITTED WITH LEAF GUARDS AND SHOULD BE INSPECTED AND CLEANED TO ENSURE LEAF LITTER CANNOT ENTER THE DOWNPIPES

SYMBOLS FINISHED FLOOR LEVEL F. F. L. Т.К. TOP OF KERB PIT SURFACE LEVEL INVERT LEVEL STORMWATER DRAINAGE PIPE DOWNPIPE TO RAINWATER TANK 100 ф DOWN PIPE (U.N.O.) • DP SPREADER INSPECTION EYE MASONRY RETAINING WALL FLOOR WASTE 150 Φ GRATED INLET PIT GRATED DRAIN OVERLAND FLOW PATH


EMERGENCY SPILTTER

EXISTING 100 φ DOWN PIPE (U. N. O.)

EXISTING STORMWATER DRAINAGE PIPE

VERTICAL DROP



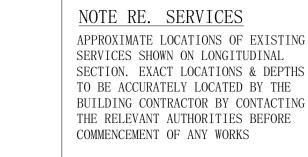



- 1. ALL LINES ARE TO BE MIN. 100 Φ UPVC @ MIN 1.0% GRADE UNLESS NOTED OTHERWISE.
- 2. IT IS THE CONTRACTORS RESPONSIBILITY TO LOCATE & LEVEL ALL EXISTING SERVICES PRIOR TO THE COMMENCEMENT OF ANY EARTHWORKS. ALL DESIGN LEVELS SHOWN ON PLAN SHALL BE VERIFIED ON SITE PRIOR TO THE COMMENCEMENT OF ANY WORK.
- 3. ALL PIPES TO HAVE MIN 200mm COVER IF LOCATED WITHIN PROPERTY.
- 4. ALL PITS IN DRIVEWAYS BE HEAVY DUTY GRATES. DIRECT SURFACE FLOW TO ALL GRATED SURFACE INLET PITS.
- 5. ALL WORK DO BE DONE IN ACCORDANCE WITH AS/NZ 3500. 3. 2: 2003 AND COUNCIL SPECIFICATIONS.
- 6. LOCATION OF DOWNPIPES & FLOOR WASTES ARE INDICATIVE ONLY. DOWNPIPE & FLOOR WASTE SIZE, LOCATION & QUANTITY TO BE DETERMINED BY BUILDER & IN ACCORDANCE WITH RELEVANT AUSTRALIAN STANDARDS.
- 7. THIS PLAN IS TO BE READ IN CONJUNCTION WITH THE ARCHITECTURAL, LANDSCAPE AND STRUCTURAL PLANS.
- 8. ANY DISCREPANCIES OR OMISSIONS SHALL BE REFERRED TO THE DESIGN ENGINEER FOR RESOLUTION.
- 9. ALL PITS OR GRATES IN TRAFFICABLE AREAS TO BE HEAVY
- 10. ALL GUTTERS WILL BE FITTED WITH LEAF GUARDS AND SHOULD BE INSPECTED AND CLEANED TO ENSURE LEAF LITTER CANNOT ENTER THE DOWNPIPES

SYMBOLS

	•
F. F. L.	FINISHED FLOOR LEVEL
Т. К.	TOP OF KERB
RL	PIT SURFACE LEVEL
IL	INVERT LEVEL
	STORMWATER DRAINAGE PIPE
	DOWNPIPE TO RAINWATER TANK
• DP	100 ф DOWN PIPE (U.N.O.)
■ SP	SPREADER
• IE	INSPECTION EYE
	MASONRY RETAINING WALL
⊗FW	FLOOR WASTE 150 Φ
	GRATED INLET PIT
	GRATED DRAIN
<u></u>	OVERLAND FLOW PATH
	O'LIGHT I LOW I MIII
ES	EMERGENCY SPILTTER

VD VERTICAL DROP EXISTING 100 φ DOWN PIPE (U. N. O.) EXISTING STORMWATER DRAINAGE PIPE

4 x 460mm PSorb (MCC) eatment Train Effectiveness - Receiving Node Residual Load % Reduction

> 88.9 69.4

45.2

100

2.41

Drawing Title SITE STORMWATER DRAINAGE DETAIL

51.5

OCEANGUARD PIT BASKET

Total Nitrogen (kg/yr)

Gross Pollutants (kg/yr)

Roof - 1362m2 (100% Imp.) [Roof]

Carpark - 935m2 (100% Imp.) [Sealedroad]

Pedestrian path - 158m2 (100% Imp.) [Mixed]

619-621 HUME HWY,

CASULA, NSW

Pervious to OSD - 316m2 (100% Perv.) [Mixed]


Ground - 69m2 (100% Perv.) [Mixed]

THESE DRAWINGS AND THE DESIGNS WITHIN ARE COPYRIGHT. THEY ARE NOT TO BE USED FOR ANY PURPOSE OTHER THAN THE NOMINATED PROJECT. THE DRAWINGS REMAIN THE PROPERTY OF SHENS AND ARE NOT TO BE REPRODUCED OR ALTERED WITHOUT WRITTEN PERMISSION.

NOT FOR CONSTRUCTION



Project Number SH18171	Drawing Number ST05	Revison
Engineer SH	Drawn	
JUL 2019	Scale 1:100	A1

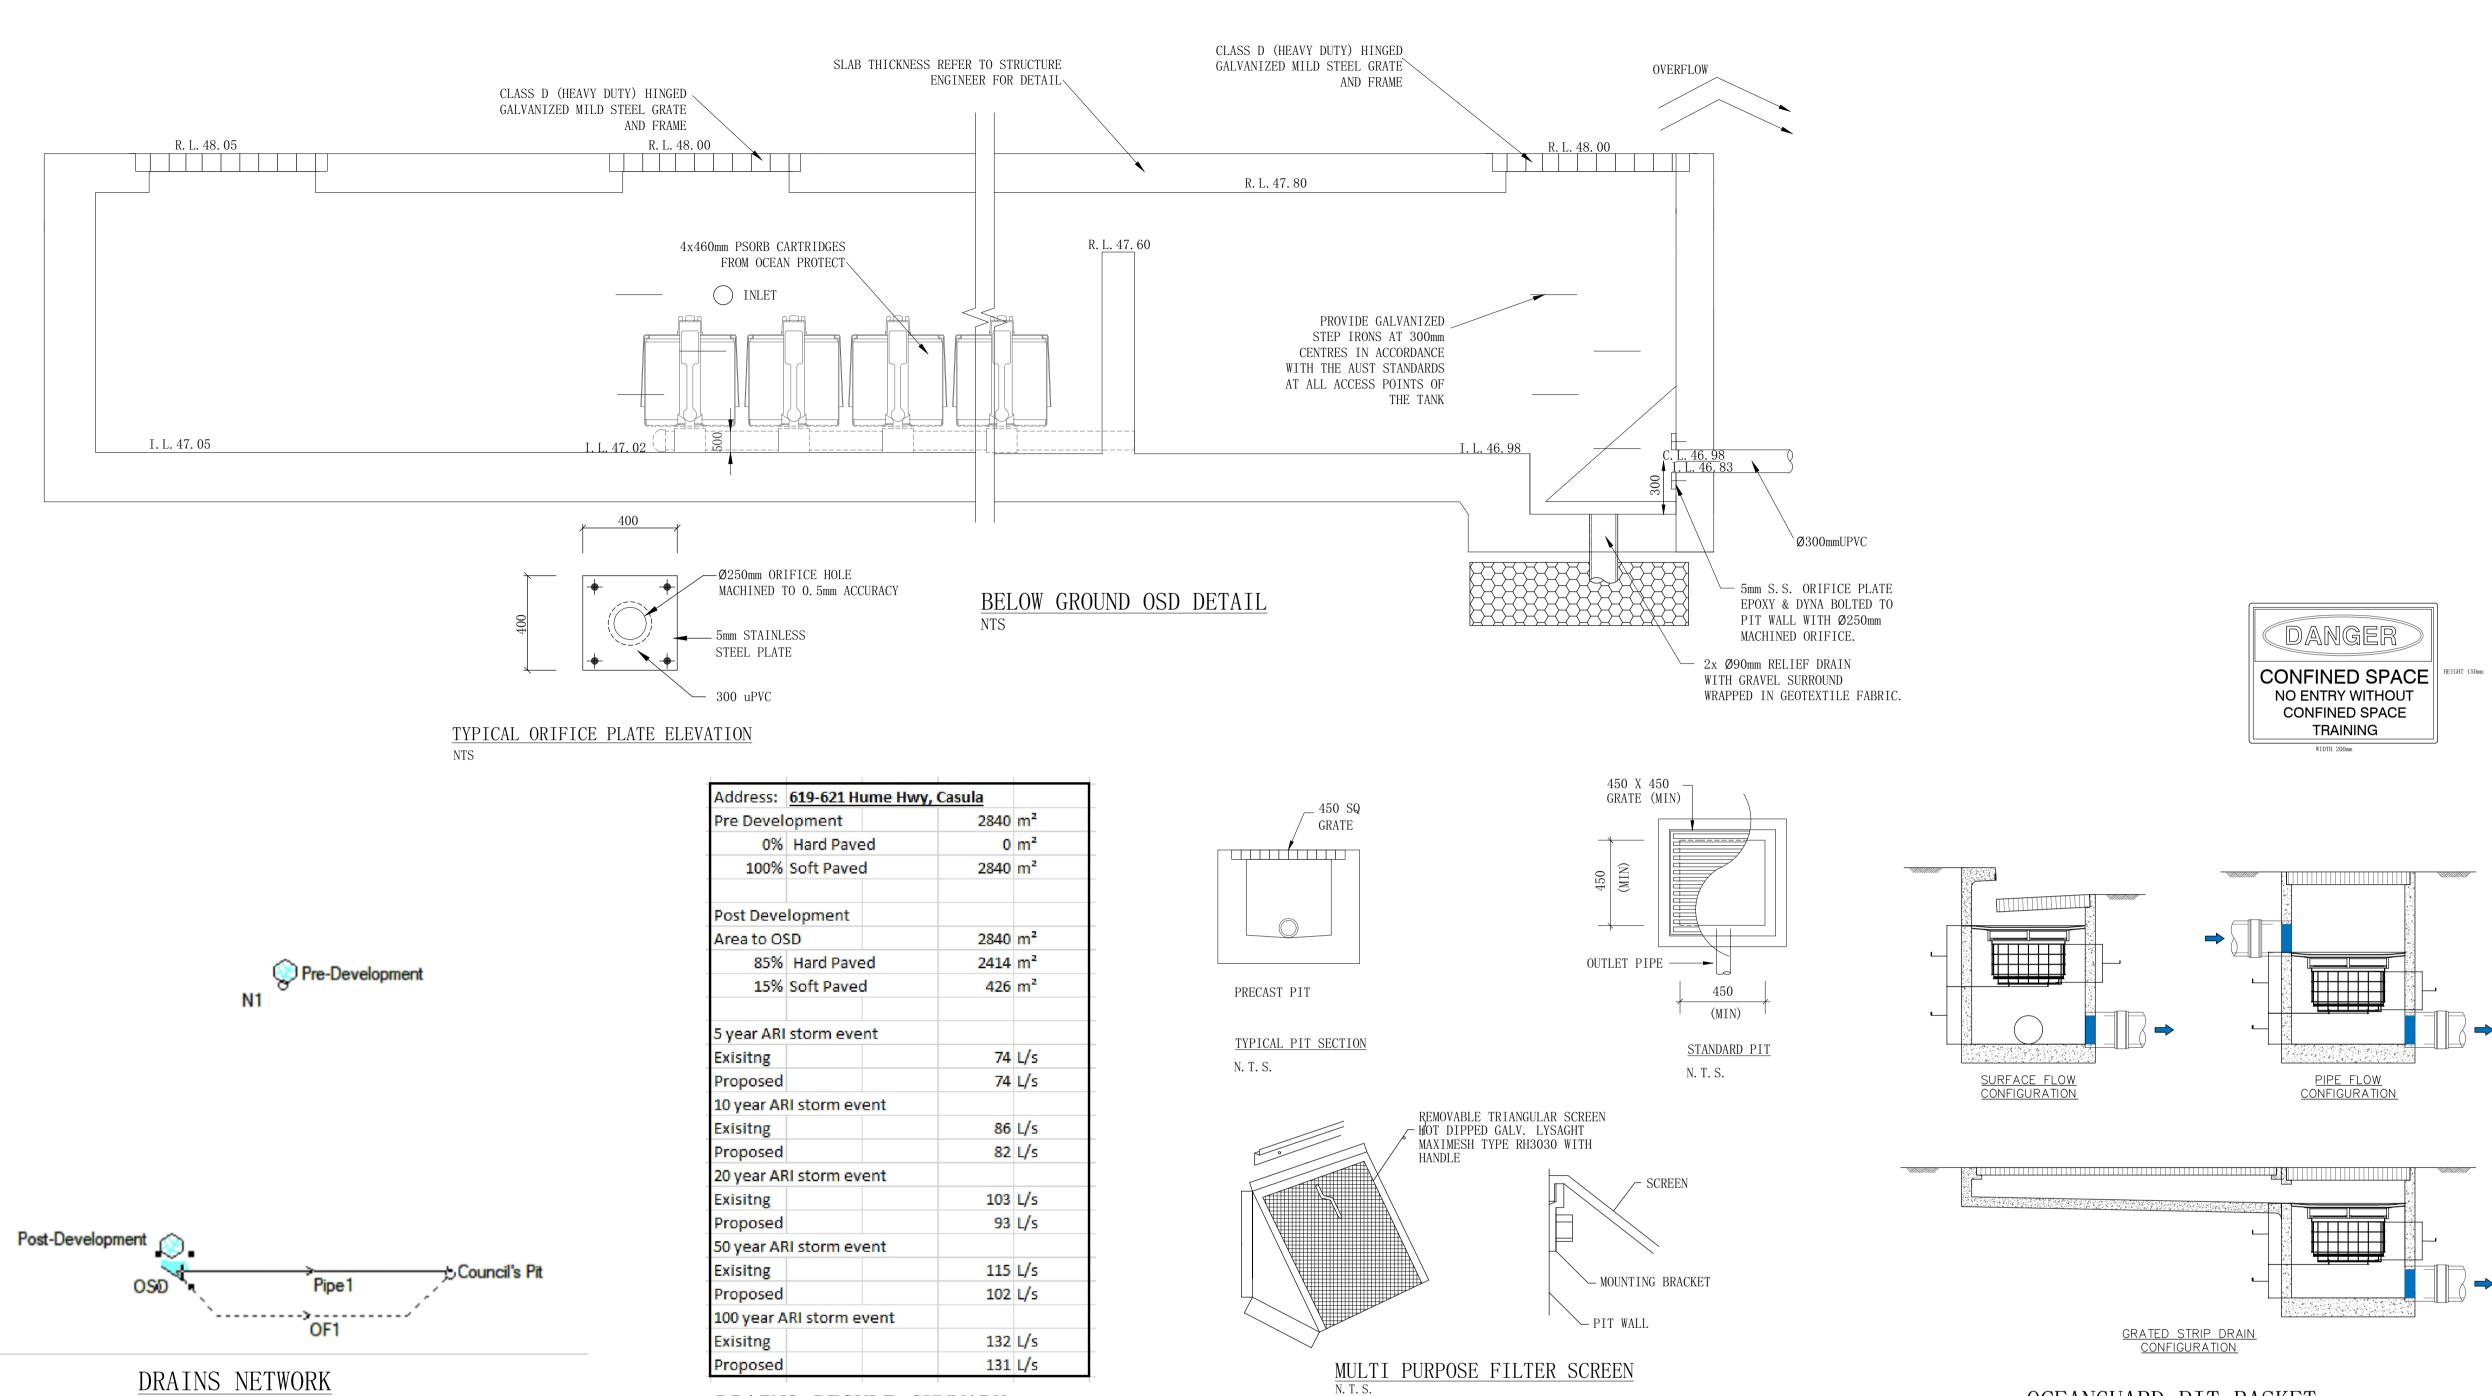

© 0.132

0.103

DREAMSCAPES ARCHITECTS

Address 1502, Level 15, Citadel Towers, Tower B 799 Pacific Highway, Chatswood NSW 2067 Phone (02) 80688318 Email info@dreamsgroup.com.au Website www.dreamsgroup.com.au ACN 169 027 936

0.028

100 YEAR ARI

0.165

47.87 47.26

STRONGHOLD ENGINEERS

Email: admin@shens.com.au

ULTIMO NSW 2007

Suite 79 89-97 JONES STREET

DRAINS RESULT SUMMARY

№ 0.086

0.082

Engineering Consultant

SHENS

`-----

10 YEAR ARI

0.111 🚕

47.63

By App Date

№ 0.074

0.074

SH IN 02/08/21

SH IN 15/07/21

SH IN 22/07/19

By App Date

`-----

5 YEAR ARI

0.099

47.23

FOR DA APPROVAL

FOR DA APPROVAL

FOR DA APPROVAI

